



PA-SHT REV. 5

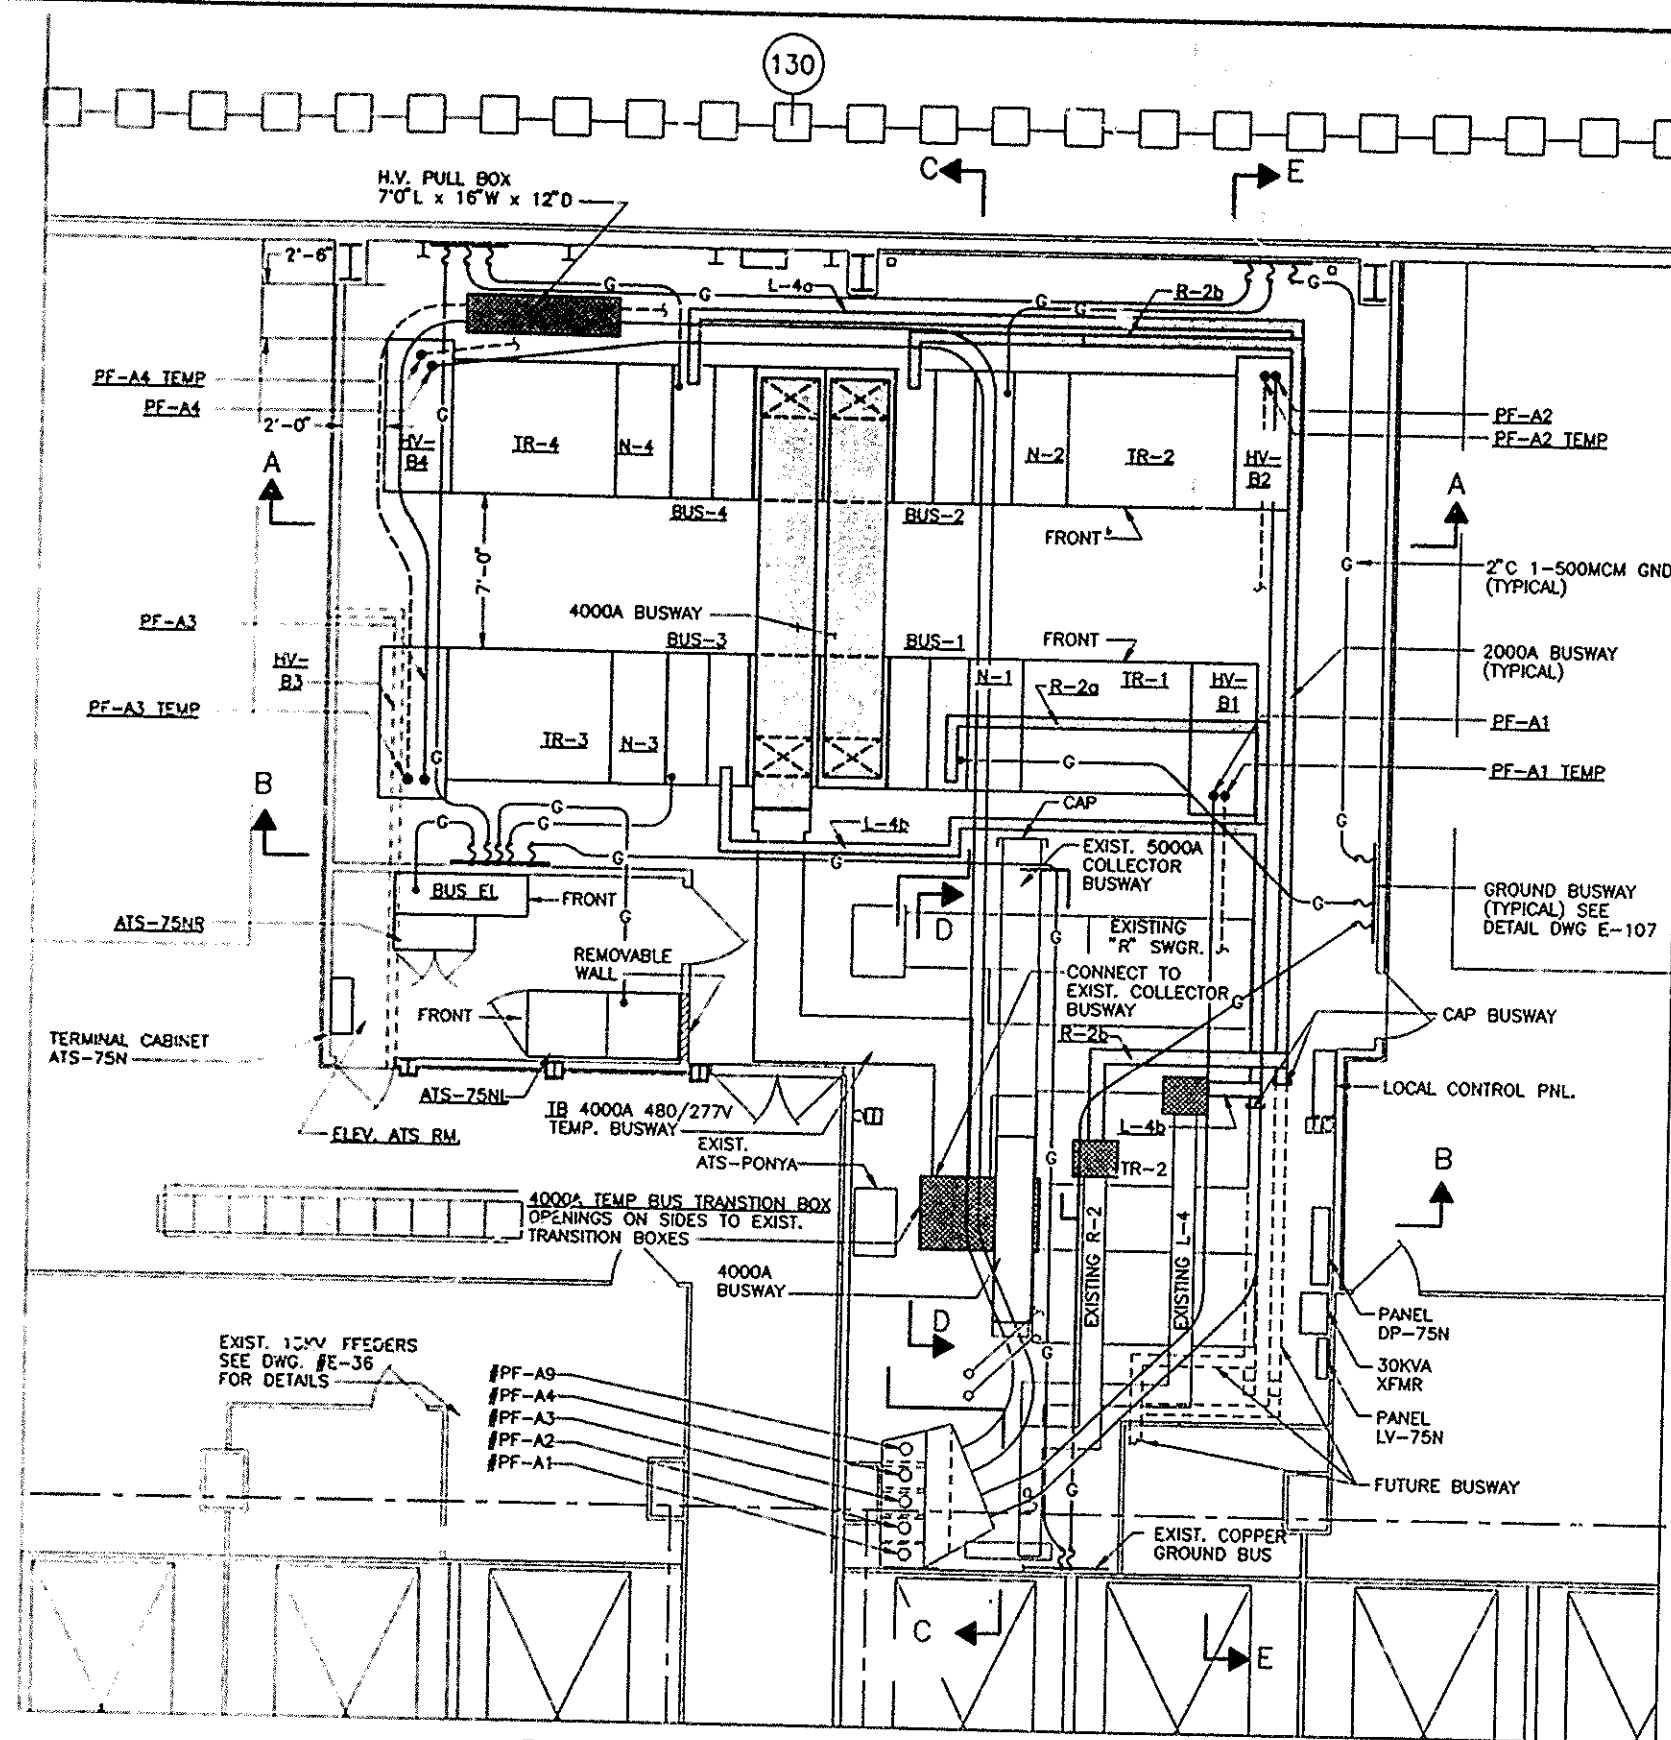


PART PLAN - 75TH FLOOR

SCALE IN FEET
0 4 8 12 16

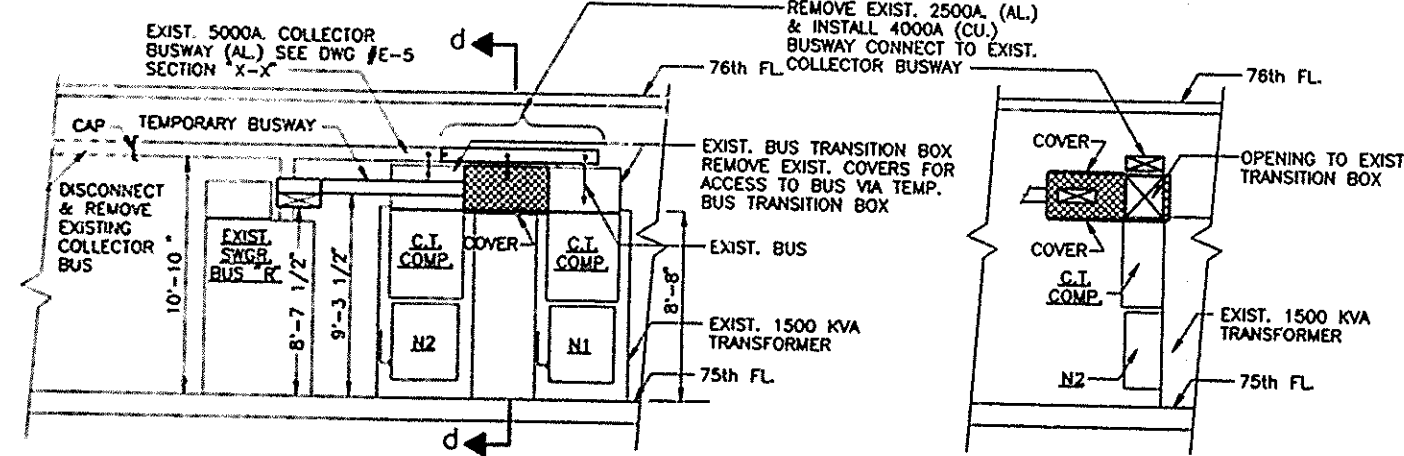


SECTION D-D


SECTION d-d

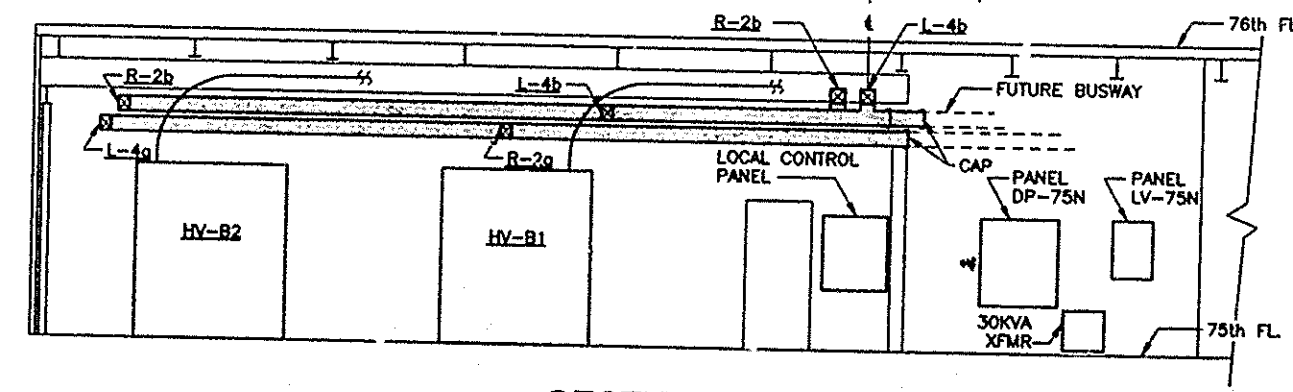


SECTION E-E

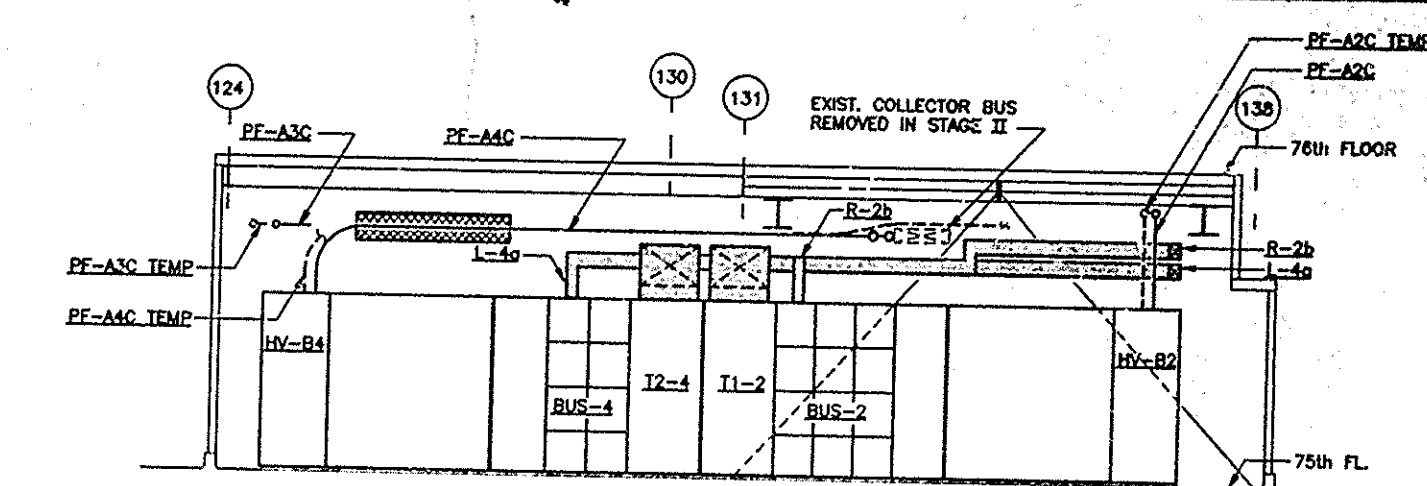

SECTION A-A

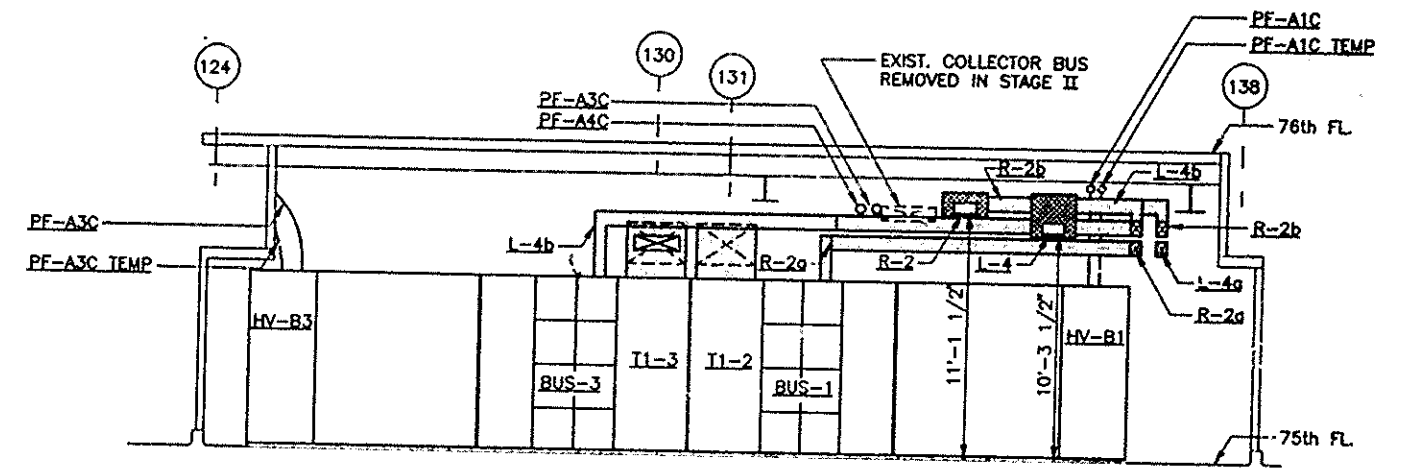

SECTION B-B

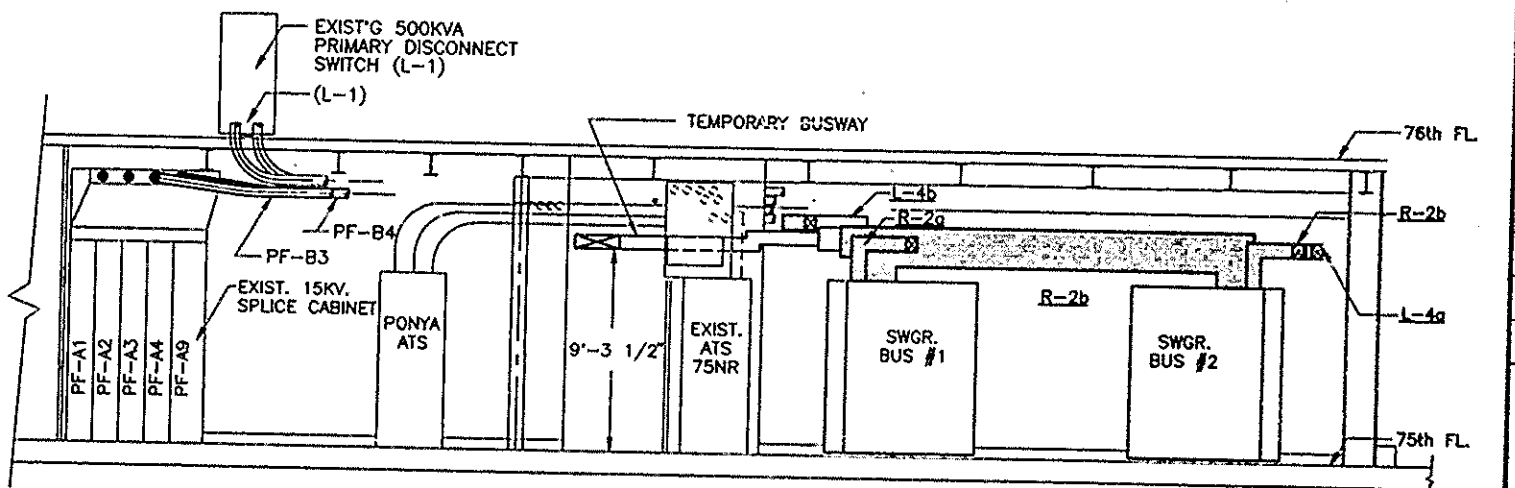

SECTION C-C

I HEREBY CERTIFY THAT THIS IS A TRUE AND CORRECT COPY OF ONE OF THE CONTRACT DRAWINGS, CONSTITUTING A PART OF CONTRACT NO. WTC-802.071 IN THE FORM IN WHICH SAID DRAWINGS EXISTED AT THE TIME THE SAID CONTRACT WAS EXECUTED BY THE PARTIES.

DATE 6/20/95 *Samir A. Aslam* SPEC. WRITER
DATE 8/15/95 *Peter K. Sweeney* ENGINEER OF DESIGN

NOTE:

- THIS DRAWING SHOWS BOTH STAGE II AND III WORK COMBINED. FOR SEPARATION OF WORK SEE NOTE #3 DWG. #E-39.
- FOR WORK IN ELECTRIC CLOSET "C" SEE DRAWING E-40, ONE LINE DIAGRAM.
- FOR LOCAL CONTROL PANEL DETAILS SEE DRAWING E-107.
- FOR BUSWAY REQUIREMENTS SEE DWG. #E-2 GENERAL NOTE #17.

Sheet 128 of 224

THE PORT AUTHORITY
OF NY & NJ

Peter K. Sweeney
ENGINEERING PROGRAM MANAGER
WORLD TRADE CENTER
Samir A. Aslam
SPE. WRITER

Engineering Department
Design Division
The World Trade Center
Electrical/HVAC
Upgrade Program

Title
**TOWER ONE AND TWO
LOW VOLTAGE
SUBSTATIONS
CONSTRUCTION AND
INSTALLATION**

ELECTRICAL
**SUBSTATION SS-75N
STAGE II AND III
SWITCHGEAR EQUIPMENT
PLAN & SECTIONS**

No.	Date	Revision	Approved
1	8-1-95		
This drawing subject to conditions in contract. All inventions, ideas, designs and methods herein are reserved to Port Authority and may not be used without its written consent.			
<i>LEAHY/FISCHER</i>			
Designed by	Drawn by	Checked by	
Date 8-1-95			Scale AS NOTED
Contract Number			Drawing Number
WTC 802.071			E-42